


Site Finishes		
Material	Vendor	Color
Pavers	Tremron - Plank	Sand Dune
Street Lights	Cooper Lighting Solutions	ECM Classical Type 4
Pedestrian Lighting	Lithonia Lighting	Radean Bollard
Entry Gates	Hoover Fence - Ideal	Black
Sports Court	Hoover Fence Co	Powder Coated Black
Fencing	Homeland Vinyl Products	Ranch Rail

RV Pads		
Material	Vendor	Color
Pavers	Tremron - Stonehurst Smooth	Sand Dune
Firepit	Tremron - Stonehurst Smooth	Sand Dune
Cabana	Yardcraft	A-Frame Pavilion

IDEAL

#8610 Aluminum Double Swing Estate Gate

Item # IXE-8610

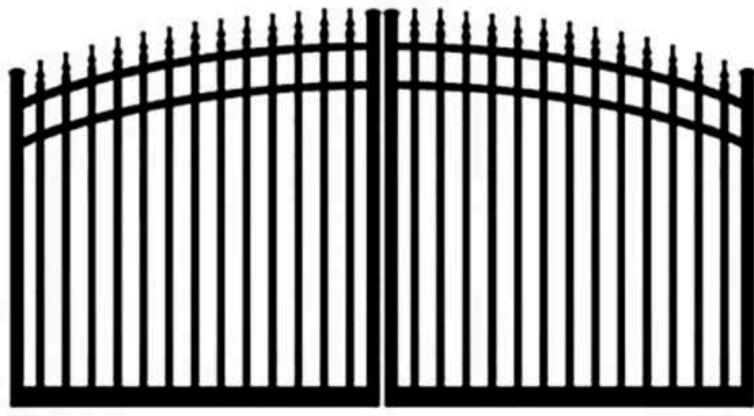

Actual product(s) may vary from pictures shown



Q

Quantity:

-

1

+

ADD TO CART

+ ADD TO PROJECTS

Height: 6/7'



Width: 24'



Color: Black



Finials:



Ranch Rail Program



Homeland Vinyl Products, Inc.




Waymark Accessories can add extra value. Add a decorative cap or even solar lighting to Ranch Rail. Metal and Tiffany style tops are also available to add a more elegant appearance.





WaymarkProducts.com


1-1/2" x 5-1/2" Two Ranch Rail

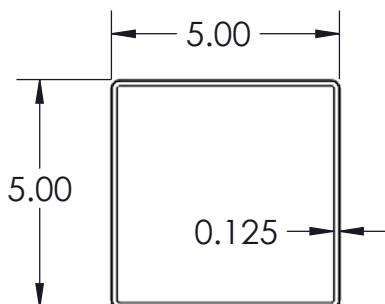

F10J
5" x 5"
Co-Ex Utility Ranch Post

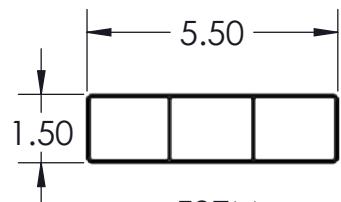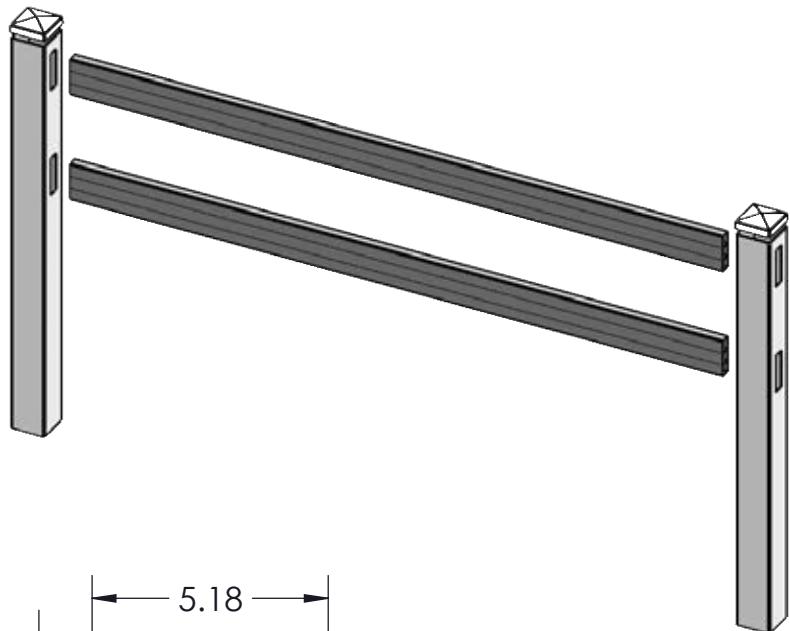

F27M
1½" x 5½"
Co-Ex Utility Value Rail

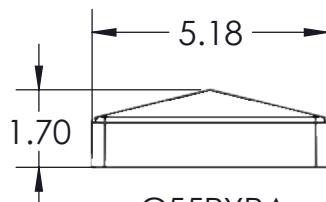

C55PYRA
5" x 5"
External Pyramid Post Cap

PLANT AVAILABILITY
ALABAMA and TEXAS
ONLY

L12 Rail Bundles PER TRUCK **/14** Post Bundles PER TRUCK
48' TRUCK



COPYRIGHT HOMELAND VINYL PRODUCTS, INC.

This drawing is the property of Homeland Vinyl Products, Inc. It is not to be reproduced, copied or traced in whole or in part without the written consent of Homeland Vinyl Products, Inc.

TITLE:

1½" x 5½" Two Ranch Rail

DRAWN BY:

ALW

DATE:

4/29/2022

SCALE:

1 : 24


ROUTE PATTERN:

#R23


DWG NO.

HVRR-10

1-1/2" x 5-1/2" Three Ranch Rail

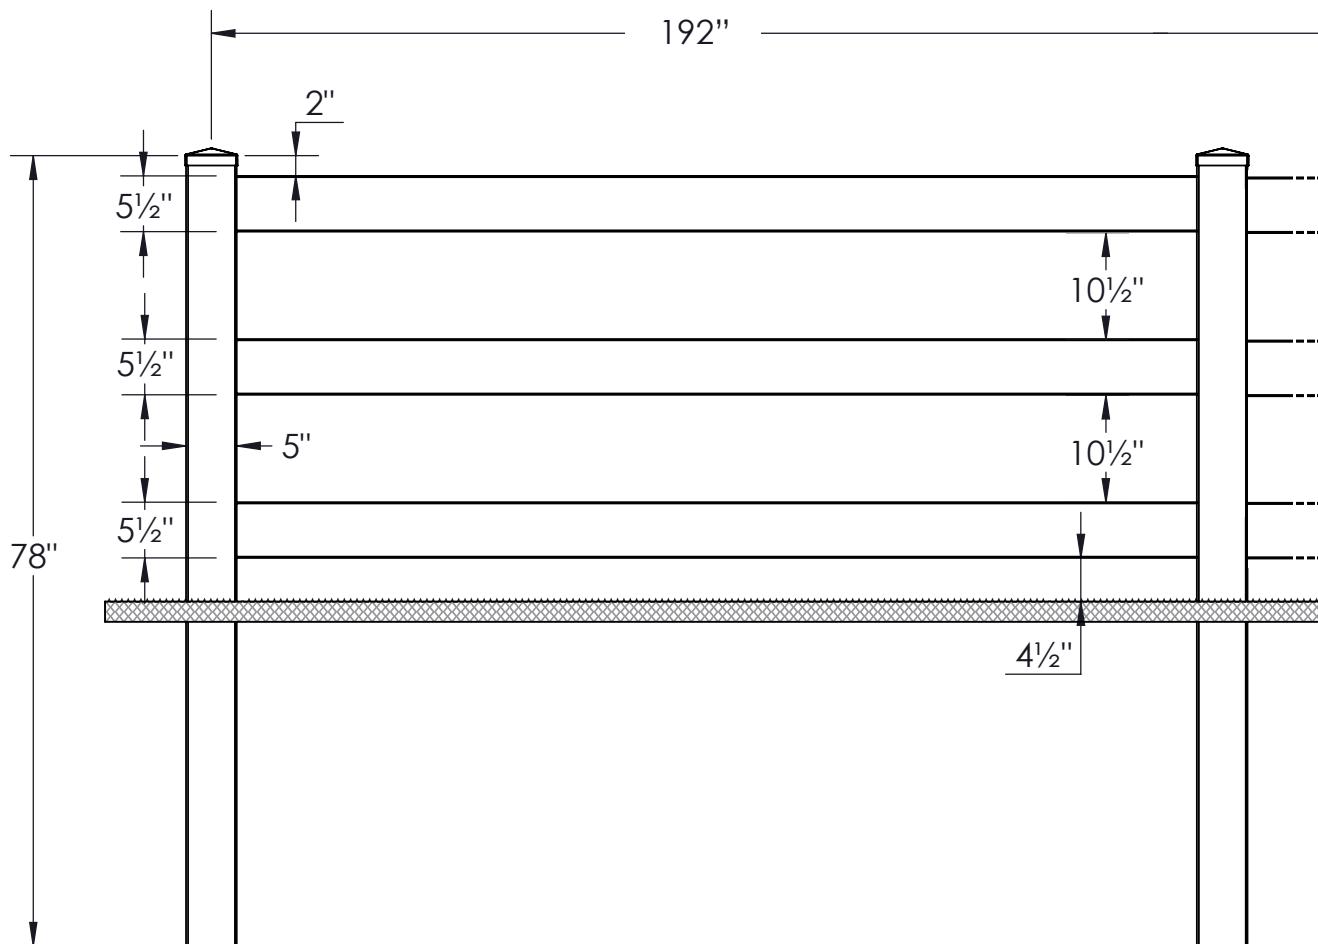

Quantity	Item Key	Description
2	C55PYRA	5" X 5" External Pyramid Post Cap
3	F27M	1-1/2" x 5-1/2" x 192" Co-Ex Utility Value Rail
2	F10J	5" x 5" x 78" Co-Ex Utility Ranch Post
Ranch Rail RediPak HVP Bundle Item Keys		

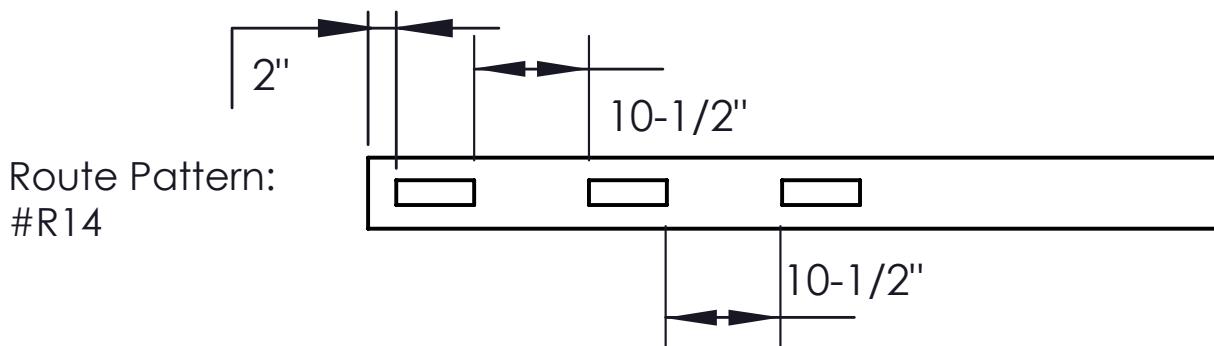

COPYRIGHT HOMELAND VINYL PRODUCTS, INC.

This drawing is the property of Homeland Vinyl Products, Inc. It is not to be reproduced, copied or traced in whole or in part without the written consent of Homeland Vinyl Products, Inc.

TITLE:

1 1/2" x 5 1/2" Three Ranch Rail

DRAWN BY:

ALW


DATE: 5/2/2022

SCALE: 1 : 18



ROUTE PATTERN: #R14

DWG NO. HVRR-11


1-1/2" x 5-1/2" Three Ranch Rail

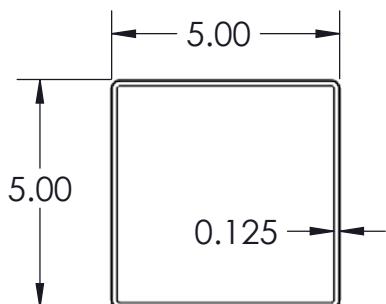

F10J
5" x 5"
Co-Ex Utility Ranch Post

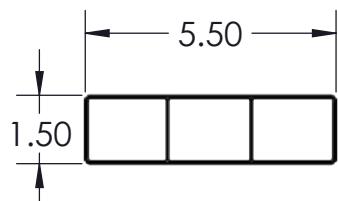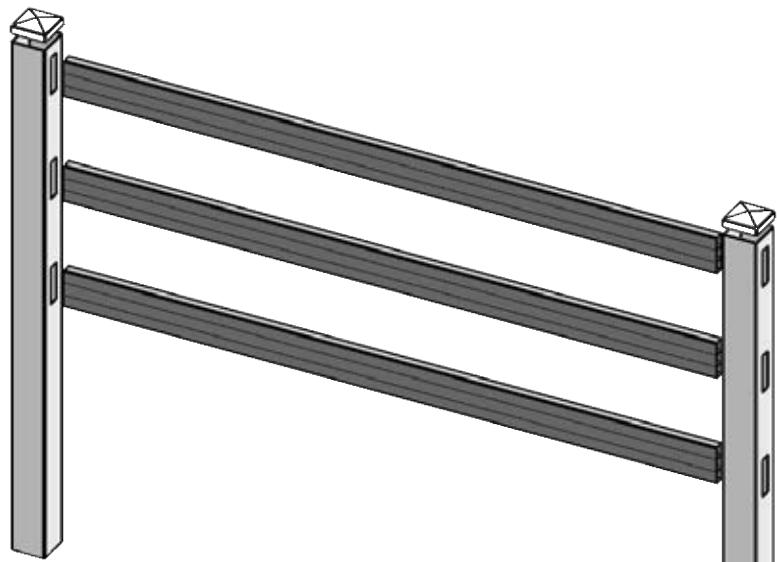

F27M
1½" x 5½"
Co-Ex Utility Value Rail

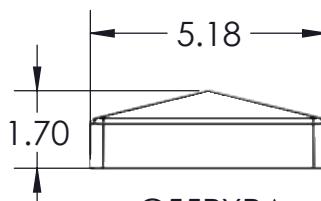

C55PYRA
5" x 5"
External Pyramid Post Cap

PLANT AVAILABILITY

ALABAMA and TEXAS
ONLY

12 Rail Bundles PER TRUCK **/14** Post Bundles PER TRUCK
48' TRUCK ●●



This drawing is the property of Homeland Vinyl Products, Inc. It is not to be reproduced, copied or traced in whole or in part without the written consent of Homeland Vinyl Products, Inc.

TITLE:

1½" x 5½" Three Ranch Rail

DRAWN BY:

ALW

DATE:

5/2/2022

SCALE:

1 : 24


ROUTE PATTERN:

#R14


DWG NO.

HVRR-11

1-1/2" x 5-1/2" Two Ranch Rail

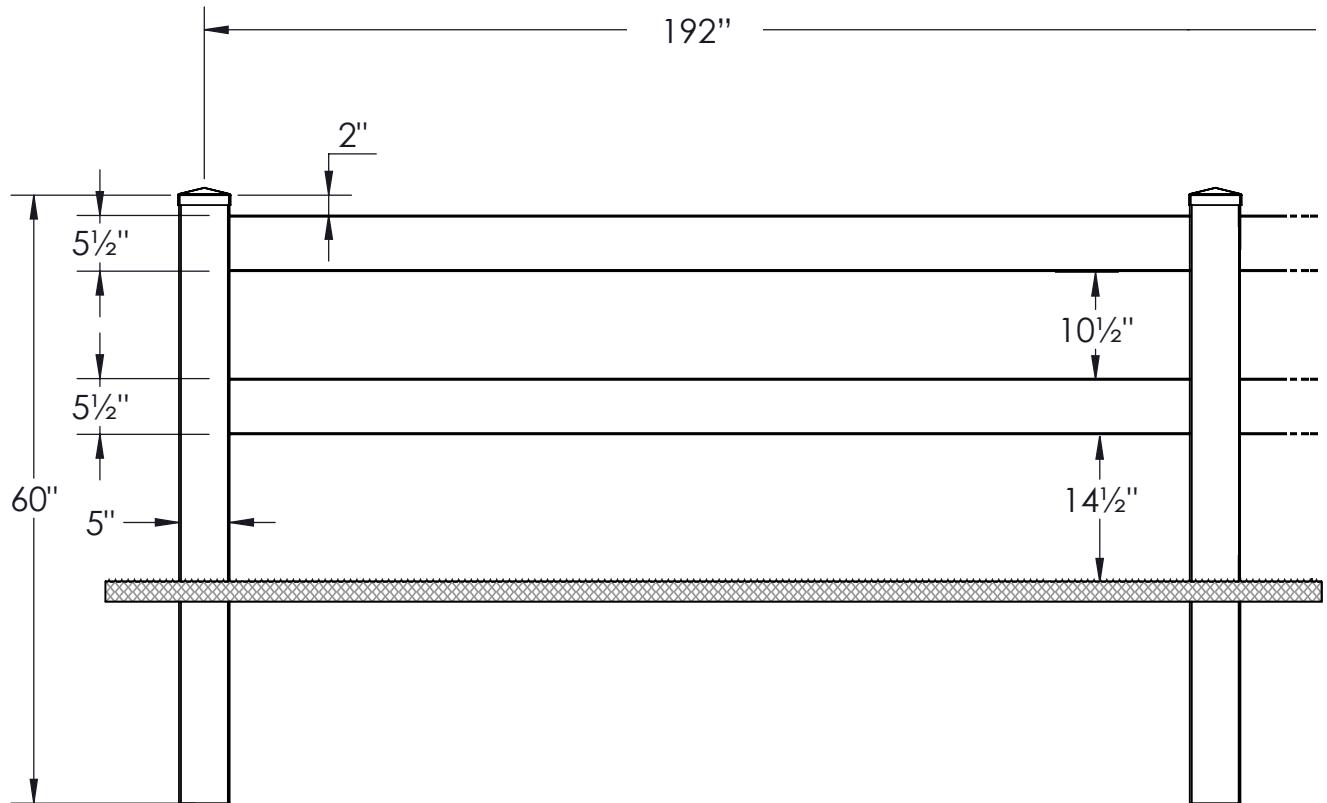

Quantity	Item Key	Description
2	C55PYRA	5" X 5" External Pyramid Post Cap
2	F27M	1-1/2" x 5-1/2" x 192" Co-Ex Utility Value Rail
2	F10J	5" x 5" x 60" Co-Ex Utility Ranch Post
Ranch Rail RediPak HVP Bundle Item Keys		

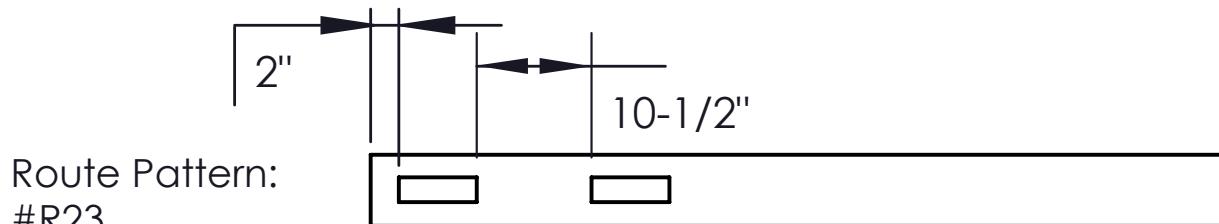

This drawing is the property of Homeland Vinyl Products, Inc. It is not to be reproduced, copied or traced in whole or in part without the written consent of Homeland Vinyl Products, Inc.

TITLE:

1 1/2" x 5 1/2" Two Ranch Rail

DRAWN BY:

ALW

DATE:

4/29/2022

SCALE:


1 : 18

ROUTE PATTERN:

#R23


DWG NO.:

HVRR-10

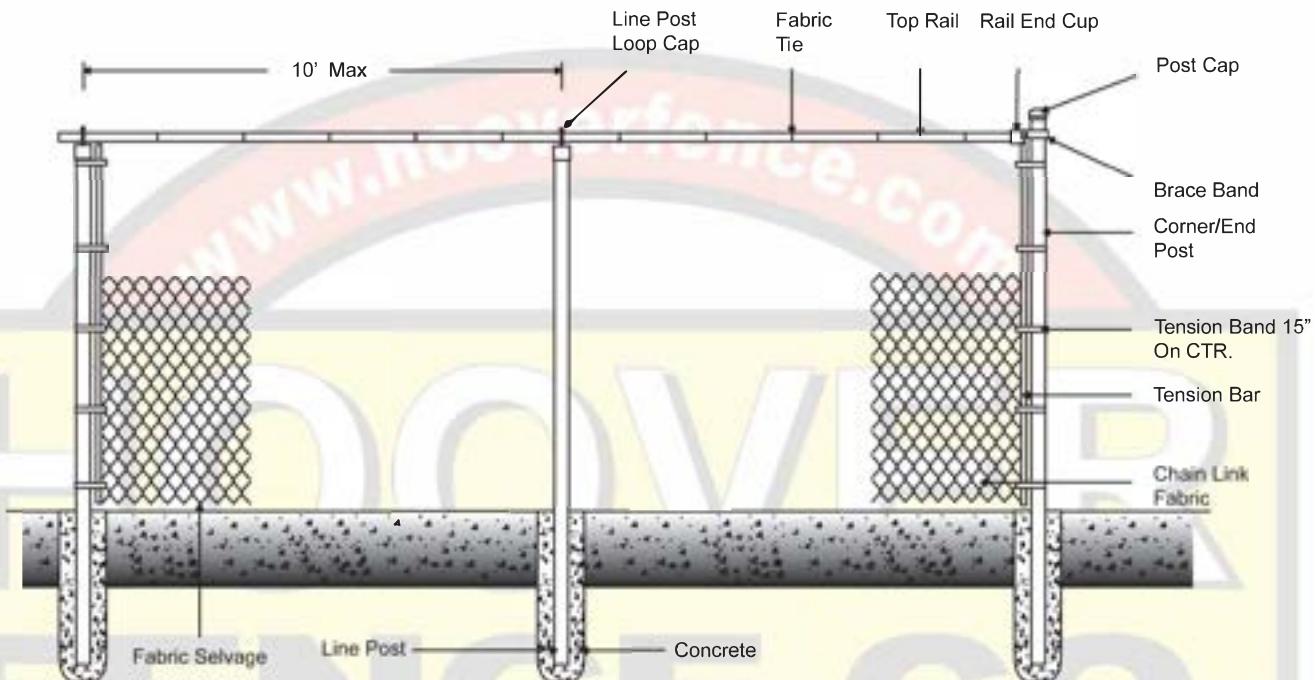

Height	Mesh	Gage	Selvage	Finish
work	O.D.	Wall	Wt. per ft.	Length
l/Corner Post				
e Post				
ls				
te Frame				
te Post				

Notes
 - Gate Fabric to match fence
 - For more information please see
www.hooverfence.com

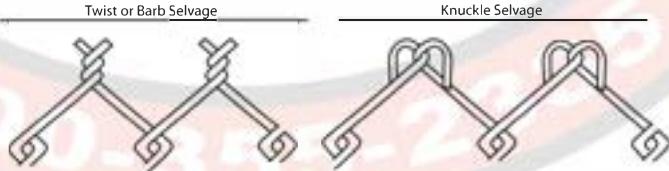

Last Revised: 10-03-06

Standard Chain Link Fencing

3'-6' Chain Link Fence W/Top Rail Detail

Approved By/Date	Revision NO.	4	Drawing NO.
Drawn By	Effective Date		



Project		Catalog #		Type	
Prepared by		Notes		Date	



Invue

ECM/EMM Epic Medium LED

Decorative Area Luminaire

Product Features



Product Certifications




Interactive Menu

- Order Information [page 2](#)
- Optical Distributions [page 3](#)
- Product Specifications [page 3](#)
- Mounting Accessories [page 4](#)
- Energy and Performance Data [page 8](#)
- Control Options [page 10](#)


Quick Facts

- Two housing sizes and hundreds of unique combinations
- 22 different mounting choices including single and dual fixture mounts
- Heavy-gauge precision spun aluminum shades
- One-piece silicone gasket to prevent moisture and dust entry
- Offered standard in 4000K (+/- 275K) CCT and nominal 70 CRI
- Base casting slipfits over a standard 4" O.D. pole or 4"x6" O.D. tenon

Dimensional Overview

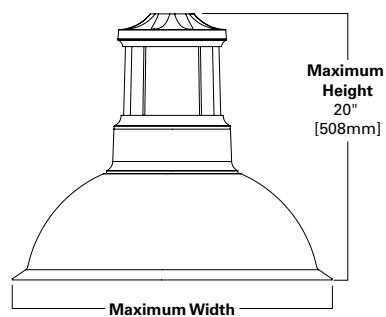

ECM Classical

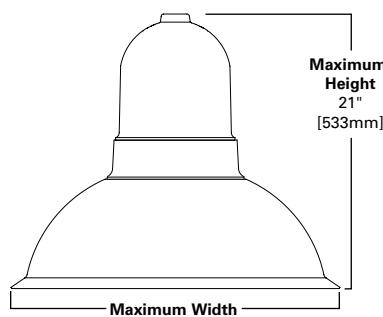

EMM Modern


Ordering Information

SAMPLE NUMBER: ECM-E04-LED-E1-T2-FL-GM

Product Family ¹	Number of LightBARs ^{2,3}	Lamp Type	Voltage	Distribution	Mid Section Type	Shade Type	Color ⁵	
ECM =Epic Classical Medium EMM =Epic Modern Medium BAA-ECM =Epic Classical Medium Buy American Act Compliant ¹⁹ BAA-EMM =Epic Modern Medium Buy American Act Compliant ¹⁹	E01 =(1) 21 LED LightBAR E02 =(2) 21 LED LightBARs E03 =(3) 21 LED LightBARs E04 =(4) 21 LED LightBARs F01 =(1) 7 LED LightBAR F02 =(2) 7 LED LightBARs F03 =(3) 7 LED LightBARs F04 =(4) 7 LED LightBARs	LED =Solid State Light Emitting Diodes	E1 =Electronic 347=347V 480 =480V ⁴	T2 =Type II T3 =Type III T4 =Type IV SL2 =Type II w/Spill Control SL3 =Type III w/Spill Control SL4 =Type IV w/Spill Control SM0 =Type V Square Medium SW0 =Type V Square Wide SW1 =Type V Square Extra Wide RW =Rectangular Wide SLL =90° Spill Light Eliminator Left SLR =90° Spill Light Eliminator Right	SO =Solid SR =Solid Rings	SN =Straight Narrow SW =Straight Wide BL =Bell FL =Flute	AP =Grey BZ =Bronze BK =Black DP =Dark Platinum GM =Graphite Metallic WH =White	
Options (Add as Suffix)		Accessories (Order Separately) ²⁰						
2L =Two Circuits ⁶ 7030 =70 CRI / 3000K CCT ⁷ 7050 =70 CRI / 5000K CCT ⁷ 8030 =80 CRI / 3000K CCT ⁷ LCF =LightBAR Cover Plate Matches Housing Finish MS-LX =Motion Sensor for ON/OFF Operation ⁸ MS/X-LX =Motion Sensor for Bi-Level Switching ⁹ PMXX =Pendant Mount (XX=Pendant Length in Inches, 9.5" min - 48.0" max) ¹⁰ HSS =Factory Installed House Side Shield ¹¹ DIM =0-10V Dimming Driver ¹²		Accessories Options ¹⁶ OA/RA1016 =NEMA Twistlock Photocontrol - Multi-Tap OA/RA1027 =NEMA Twistlock Photocontrol - 480V OA/RA1201 =NEMA Twistlock Photocontrol - 347V OA/RA1013 =Photocontrol Shorting Cap LB/HSS-21 =Field Installed House Side Shield for "E" LightBARs ^{11,15} LB/HSS-07 =Field Installed House Side Shield for "F" LightBARs ^{11,15} Mounting Accessories (Order Separately) Classical VA6150-XX =Bishop Wall Mount Arm VA6151-XX =Bishop Wall Mount Arm with Cross Rod VA6152-XX =Traditional Wall Mount Arm VA6153-XX =Traditional Wall Mount Arm with 45° Strap VA6154-XX =Bishop Single Pole Mount Arm VA6155-XX =Bishop Single Pole Mount Arm with Cross Rod VA6156-XX =Bishop Twin Pole Mount Arm VA6157-XX =Bishop Twin Pole Mount Arm with Cross Rods VA6158-XX =Traditional Single Pole Mount Arm VA6159-XX =Traditional Single Pole Mount Arm with Rounded Upper Bar VA6160-XX =Traditional Single Pole Mount Arm with Rounded Lower Bar ¹⁴ VA6161-XX =Traditional Single Pole Mount Arm with 45° Upper Bar VA6162-XX =Traditional Single Pole Mount Arm with 45° Lower Bar ¹⁴ VA6163-XX =Traditional Single Pole Mount Arm with 45° Upper Strap VA6165-XX =Traditional Twin Pole Mount Arm VA6166-XX =Traditional Twin Pole Mount Arm with Rounded Upper Bars VA6167-XX =Traditional Twin Pole Mount Arm with Rounded Lower Bars ¹⁴ VA6168-XX =Traditional Twin Pole Mount Arm with 45° Upper Bars VA6169-XX =Traditional Twin Pole Mount Arm with 45° Lower Bars ¹⁴ VA6170-XX =Traditional Twin Pole Mount Arm with 45° Upper Straps VA6171-XX =Mast Arm Adapter Modern VA6101-XX =Bishop Wall Mount Arm VA6102-XX =Bishop Wall Mount Arm with Cross Rod VA6103-XX =Traditional Wall Mount Arm VA6104-XX =Traditional Wall Mount Arm with 45° Strap VA6105-XX =Bishop Single Pole Mount Arm VA6106-XX =Bishop Single Pole Mount Arm with Cross Rod VA6107-XX =Bishop Twin Pole Mount Arm VA6108-XX =Bishop Twin Pole Mount Arm with Cross Rods VA6109-XX =Traditional Single Pole Mount Arm VA6110-XX =Traditional Single Pole Mount Arm with Rounded Upper Bar VA6111-XX =Traditional Single Pole Mount Arm with Rounded Lower Bar ¹⁴ VA6112-XX =Traditional Single Pole Mount Arm with 45° Upper Bar VA6113-XX =Traditional Single Pole Mount Arm with 45° Lower Bar ¹⁴ VA6114-XX =Traditional Single Pole Mount Arm with 45° Upper Strap VA6116-XX =Traditional Twin Pole Mount Arm VA6117-XX =Traditional Twin Pole Mount Arm with Rounded Upper Bars VA6118-XX =Traditional Twin Pole Mount Arm with Rounded Lower Bars ¹⁴ VA6119-XX =Traditional Twin Pole Mount Arm with 45° Upper Bars VA6120-XX =Traditional Twin Pole Mount Arm with 45° Lower Bars ¹⁴ VA6121-XX =Traditional Twin Pole Mount Arm with 45° Upper Straps VA6122-XX =Mast Arm Adapter						


NOTES:

1. Arm not included. Order separately. See accessories.
2. Standard 4000K CCT and greater than 70 RI.
3. 21 LED LightBAR powered by 350mA and 7 LED LightBAR powered by 1A.
4. Only for use with 480V Wye systems. Per NEC, not for use with ungrounded systems, impedance grounded systems or corner grounded systems (commonly known as Three Phase Three Wire Delta, Three Phase High Leg Delta and Three Phase Corner Grounded Delta systems).
5. Custom and RAL color matching available upon request. Consult your lighting representative at Cooper Lighting Solutions for more information.
6. Low-level output varies by bar count. Consult factory. Requires quantity of two or more LightBARs.
7. Consult customer service for lead times and multiplier.
8. Sensor mounted to the luminaire. Available in E01-E04 and F01-F04 configurations. Replace "XX" with mounting height in feet for proper lens selection, (e.g., MS-L25). Consult factory for additional information.
9. Sensor mounted to the luminaire. Available in E02-E04 and F02-F04 configurations. Replace "X" with number of LightBARs operating in low output mode and replace XX with mounting height in feet for proper lens selection, (e.g., MS/3-L25). Maximum four bars in low output mode. Consult factory for additional information.
10. Pendant mount option "PMXX" must be used with Invue Pendant mount kit only. Includes pendant pipe, swivel hangar and canopy cover. Other pendant lengths can be specified in inches (XX). Minimum pendant length is 9-1/2". For lengths above 48", consult your lighting representative at Cooper Lighting Solutions for more information.
11. Only for use with SL2, SL3 and SL4 distributions.
12. Dimming leads provide for external 0-10V control system (by others).
13. Replace XX with color suffix.
14. Only available with traditional arms.
15. One required for each LightBAR.
16. Add as suffix to mounting accessory. Example: VA6106-BK-R.
17. Not available with finials, pendant mount "PMXX" or bishop wall mounts.
18. Requires use of 4" O.D. round straight pole.
19. Only product configurations with this designated prefix are built to be compliant with the Buy American Act of 1933 (BAA). Please refer to [DOMESTIC PREFERENCES](#) website for more information. Components shipped separately may be separately analyzed under domestic preference requirements.
20. Accessories sold separately will be separately analyzed under domestic preference requirements. Consult factory for further information.

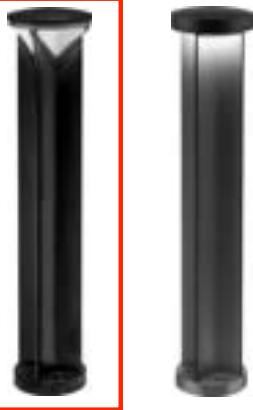

RADEAN Bollard

LED Site Luminaire

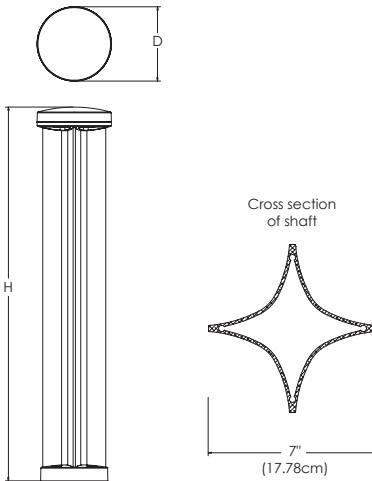

Specifications

Diameter: D = 8.25" (20.96cm)

Height: H = 41.5" Standard (105.41cm)

Weight (max): 20lbs (9.07Kg)

Catalog Number

Notes

Type

Hit the Tab key or mouse over the page to see all interactive elements.

Introduction

The Radean LED Bollard is an award-winning, energy-saving, long-life solution designed to perform the way a bollard should.

The Radean LED Bollard's rugged construction, durable finish and long-lasting LEDs will provide years of maintenance-free service.

Ordering Information

EXAMPLE: RADB LED P4 30K SYM MVOLT BTS BCCDNATXD DBLXD

RADB LED							
Series	Performance Package	Color temperature	Distribution	Voltage	Control options	Bollard top (required)	
RADB LED	P1	27K 2700 K	ASY Asymmetric ²	MVOLT ³	Shipped installed	Slim Top	Tall Top
	P2	30K 3000 K	SYM Symmetric ¹	120	PE Photoelectric cell, button type ^{4,5}	BTS Slim top, painted to match shaft ^{5,9}	BTT Tall top painted to match shaft ⁹
	P3	35K 3500 K		208 ³	DMG 0-10V dimming driver (no controls)	BTSDWHD Slim top, white ^{5,9}	BTDBLBD Tall top, black textured ⁹
	P4	40K 4000 K		240 ³	E7WH Emergency battery backup, Certified in CA Title 20 MAEDBS1 ^{6,7,8}	BTSDBLXD Slim top, black ^{5,9}	BTDDBTX Tall top, dark bronze textured ⁹
	P5 ¹	50K 5000 K		277		BTSDDBTXD Slim top, dark bronze textured ^{5,9}	BTDDDBX Tall top, dark bronze ⁹
				347	FAO Field adjustable output ⁵	BTSDDBXD Slim top, dark bronze ^{5,9}	BTTDNATX Tall top, natural aluminum textured ⁹
				480	PIR Motion sensor Bi-level ^{3,5,6,7}	BTSDNATXD Slim top, natural aluminum textured ^{5,9}	BTTDNAXD Tall top, natural aluminum ^{5,9}
						BTSDNAXD Slim top, natural aluminum ^{5,9}	BTTDWHGXD Tall top, white textured ⁹
						BTSDWHD Slim top, white textured ⁹	BTTDWHD Tall top, white ⁹

Bollard crown (required)	Other options	Finish (required)
Deep Crown		
BCC Deep crown, painted to match shaft ⁹	BCF Flat crown, painted to match shaft ⁹	H24 ^{6,10} 24" overall height
BCCDHWD Deep crown, white ⁹	BCFDBLXD Flat crown, black textured ⁹	H30 ^{6,10} 30" overall height
BCCDBLXD Deep crown, black ⁹	BCFDBLXD Flat crown, black ⁹	H36 ^{6,10} 36" overall height
BCCDBLBD Deep crown, black textured ⁹	BCFDBBTXD Flat crown, dark bronze textured ⁹	L/AB Without anchor bolts
BCCDBBTXD Deep crown, dark bronze textured ⁹	BCFDBBXD Flat crown, dark bronze ⁹	DDBXD Dark bronze
BCCDBBXD Deep crown, dark bronze ⁹	BCFDNATXD Flat crown, natural aluminum textured ⁹	DBLXD Black
BCCDNATXD Deep crown, natural aluminum textured ⁹	BCFDNAXD Flat crown, natural aluminum ⁹	DNAXD Natural aluminum
BCCDNAXD Deep crown, natural aluminum ⁹	BCFDWHGXD Flat crown, white textured ⁹	DWHXD White
BCCDWHGXD Deep crown, white textured ⁹	BCFDWHD Flat crown, white ⁹	DBBTXD Textured dark bronze
		DBLBXD Textured black
		DNATXD Textured natural aluminum
		DWHGXD Textured white

Accessories

Ordered and shipped separately.

RADBAB U	Anchor bolts (4)	RK5RADB BCKIT (FINISH) U	Base cover with bolt caps
RADBABC DBLXD U	Replacement anchor bolt covers (specify finish) (4)	RK8RADB EMTESTMAG U	Emergency test stylus

NOTES

1 P5 only available in SYM distribution.

2 ASY has only two illuminated quadrants driven at higher drive currents to generate similar output as the SYM-4-quadrant product.

3 PIR not available with 208V or 240V.

4 PE only available with ASY.

5 PE, PIR and FAO not available with BTS.

6 E7WH and PIR only available in full height. Not available with H24, H30 or H36.





7 PIR not available with E7WH.

8 E7WH is not available with 347V or 480V.

9 Architectural and custom colors available (additional leadtimes and cost may apply).

10 42" Height is standard. H24, H30 and H36 have longer leadtimes.

Options

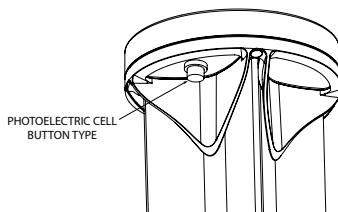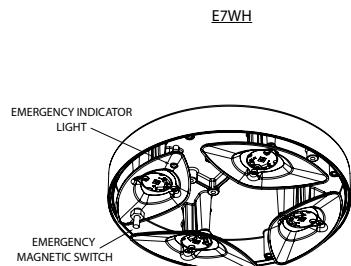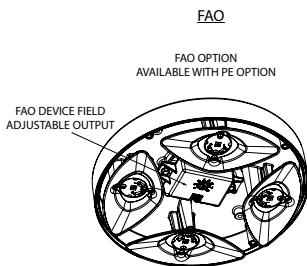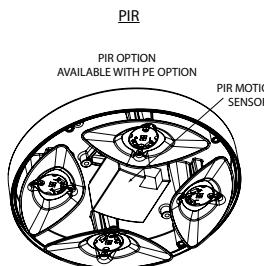

Only available with BTT tops

Only available with BTT tops

Only available with ASY

Only available with ASY

Performance Data

Lumen values are from photometric tests performed in accordance with IESNA LM-79-08. Data is considered to be representative of the configurations shown, within the tolerances allowed by Lighting Facts. Actual performance may differ as a result of an end-user environment and application. Actual wattage may differ by +/- 8% when operating between 120-480V +/- 10%.

Performance Data DNAXD Finish*

Light Engines	Performance Package	System Watts	2700K					3000K					3500K					4000K					5000K				
			Lumens	B	U	G	LPW	Lumens	B	U	G	LPW	Lumens	B	U	G	LPW	Lumens	B	U	G	LPW	Lumens	B	U	G	LPW
"Symmetric (4 light engines)"	P1	5	345	0	1	0	66	362	0	1	0	69	370	0	1	0	71	380	0	1	0	73	382	0	1	0	73
	P2	8	644	0	1	0	81	677	0	1	0	85	692	0	1	0	87	711	0	1	0	89	713	0	1	0	89
	P3	13	1036	1	1	0	77	1088	1	1	0	81	1112	1	1	0	83	1142	1	1	0	85	1146	1	1	0	85
	P4	19	1460	1	1	0	79	1534	1	1	0	83	1568	1	1	0	84	1610	1	1	0	87	1616	1	1	0	87
	P5	32	2314	1	1	0	72	2430	1	1	0	75	2484	1	1	0	77	2551	1	1	0	79	2561	1	1	0	79
"Asymmetric (2 light engines)"	P1	5	312	0	1	0	60	328	0	1	0	63	335	0	1	0	64	344	0	1	0	66	346	0	1	0	66
	P2	8	584	0	1	0	73	613	0	1	0	77	627	0	1	0	78	644	0	1	0	81	646	0	1	0	81
	P3	13	938	0	1	0	70	985	0	1	0	73	1007	0	1	0	75	1035	0	1	0	77	1038	0	1	0	77
	P4	19	1323	0	1	0	71	1390	0	1	0	75	1420	0	1	0	76	1459	0	1	0	78	1464	0	1	0	79

***Note:** Lumen output varies based on finish. Silver color shown, for black (worst) or white (best) photometry, see specific photometric files downloadable from www.acuitybrands.com

Projected LED Lumen Maintenance

Data references the extrapolated performance projections for the platforms noted in a 25°C ambient, based on 10,000 hours of LED testing (tested per IESNA LM-80-08 and projected per IESNA TM-21-11).

To calculate LLF, use the lumen maintenance factor that corresponds to the desired number of operating hours below. For other lumen maintenance values, contact factory.

Projected LED Lumen Maintenance				
	25,000	50,000	75,000	100,000
P1	0.94	0.89	0.85	0.80
P2	0.94	0.89	0.85	0.80
P3	0.94	0.89	0.85	0.80
P4	0.94	0.89	0.85	0.80
P5	0.94	0.89	0.85	0.80

Lumen Ambient Temperature (LAT) Multipliers

Use these factors to determine relative lumen output for average temperatures from 0-40°C (32-104°F).

Ambient	LAT Factor
0	32°F
5	41°F
10	50°F
15	59°F
20	68°F
25	77°F
30	86°F
35	95°F
40	104°F


Electrical Load

	Current (Amp)					Current (Amp)				
	Watts @120V (W)	Watts @277V (W)	@120V (A)	@208V (A)	@240V (A)	(@277V) (A)	Watts (@347V)	Watts (@480V)	(@347V) (A)	(@480V)
P1 ASY	5	6	0.0445	0.0299	0.0276	0.0262	10	10	0.0443	0.0319
P2 ASY	9	10	0.0751	0.0471	0.0429	0.0399	14	14	0.0505	0.0364
P3 ASY	14	15	0.1147	0.0699	0.0627	0.0571	18	18	0.0611	0.0441
P4 ASY	19	19	0.1586	0.0928	0.0819	0.0735	23	23	0.0709	0.0513
P1 SYM	5	6	0.0444	0.0301	0.0279	0.0265	9	9	0.0441	0.0319
P2 SYM	9	10	0.0734	0.0461	0.0421	0.0391	13	13	0.0502	0.0363
P3 SYM	13	14	0.112	0.067	0.0598	0.0544	18	18	0.0602	0.0435
P4 SYM	18	19	0.1535	0.0902	0.0796	0.0713	22	22	0.0691	0.0499
P5 SYM	31	31	0.2597	0.1527	0.1326	0.1149	35	36	0.1079	0.079


Photometric Diagrams

To see complete photometric reports or download .ies files for this product, visit Lithonia Lighting's [RADEAN Bollard homepage](#).

Isofootcandle plots for the RADB. Distances are in units of mounting height (3.5').

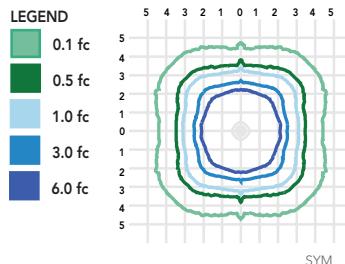

Test No. LTL24340-2 tested in accordance with
IESNA LM-79-08.

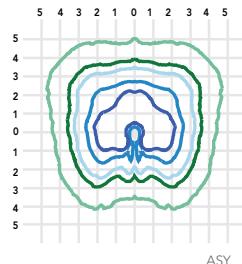

Test No. LTL24348 tested in accordance with
IESNA LM-79-08.

FEATURES & SPECIFICATIONS

INTENDED USE

The rugged construction and maintenance-free performance of the Radean LED Bollard is ideal for illuminating building entryways, walking paths and pedestrian plazas, as well as any other location requiring a low-mounting-height light source.

CONSTRUCTION

One-piece extruded aluminum shaft with thick side walls for extreme durability, and die-cast reflector and top cap. Four 3/8" x 7" anchor bolts with double nuts and washers and 5-2/3" max. bolt circle template ensure stability. Overall height is 42" standard.

FINISH

Exterior parts are protected by a zinc-infused super durable TGIC thermoset powder coat finish that provides superior resistance to corrosion and weathering for maximum retention of gloss and luster. A tightly controlled multi-stage process ensures a minimum 3-mil thickness for a finish that can withstand the elements without cracking or peeling. Available in both textured and non-textured finishes.

OPTICS

Two optical distributions are available: symmetrical and asymmetrical. IP66 sealed LED light engine provides smoothly graduated illumination. Light engines are available in 2700K, 3000K, 3500K, 4000K or 5000K.

ELECTRICAL

Light engines consist of high-efficacy LEDs mounted to metal-core circuit boards to maximize heat dissipation and promote long life (L80/100,000 hours at P5 at 25°C). Class 2 electronic drivers are designed for an expected life of 100,000 hours with < 1% failure rate. Electrical components are mounted on a removable power tray.

LISTINGS

CSA certified to U.S. and Canadian standards. Light engines are IP66 rated. Rated for -40°C minimum ambient. Emergency battery backup rated for -10°C minimum ambient. International Dark-Sky Association (IDA) Fixture Seal of Approval (FSA) is available for all products on this page utilizing 3000K color or less. U.S. Patent No. D912,850S

GOVERNMENT PROCUREMENT

BAA – Buy America(n) Act: Product qualifies as a domestic end product under the Buy American Act as implemented in the FAR and DFARS. Product also qualifies as manufactured in the United States under DOT Buy America regulations. BABA – Build America Buy America: Product qualifies as produced in the United States under the definitions of the Build America, Buy America Act. Please refer to www.acuitybrands.com/buy-american for additional information.

WARRANTY

Five-year limited warranty. This is the only warranty provided and no other statements in this specification sheet create any warranty of any kind. All other express and implied warranties are disclaimed. Complete warranty terms located at: www.acuitybrands.com/support/warranty/terms-and-conditions

Note: Actual performance may differ as a result of end-user environment and application and color.

All values are design or typical values, measured under laboratory conditions at 25 °C. Specifications subject to change without notice.

Stonehurst Smooth



Stonehurst Smooth is a recreation of a popular classic paver, featuring a refined textured surface that offers a sleek and contemporary aesthetic. The elegant smooth finish, with a reduced bevel edge, enhances the upscale appeal of any outdoor space. This paver is ideal for achieving a modern farmhouse look in driveways, pool decks, patios and walkways.

Standard Colors:



Glacier



Lionsbridge



Sand Dune



Sierra

Size Chart:



6x9



9x9



9x12

Paver Info:

PRODUCT # PV21495W2075 - Glacier
PV21495W3330 - Lionsbridge
PV21495W3220 - Sand Dune
PV21495W3320 - Sierra

DIMENSIONS (in.) 6x9, 9x9, 9x12

THICKNESS (in.) 2-3/8

SF PER CUBE 116


CUBE WEIGHT (lbs.) 3,016

SURFACE: Smooth Top


Due to variations in printing, color selections should always be chosen from actual product samples.



12x12 Pavilion

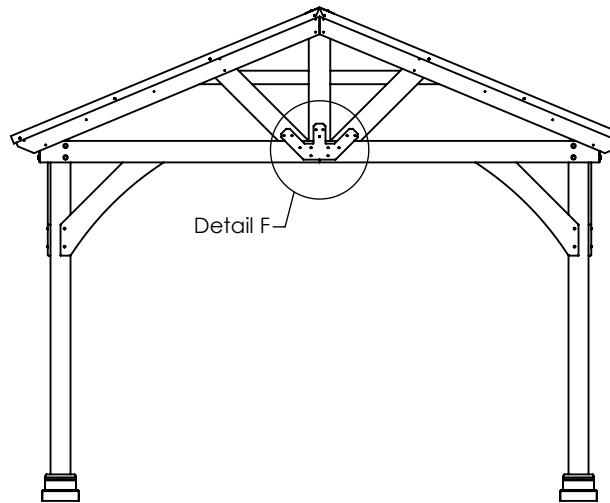

End Elevation

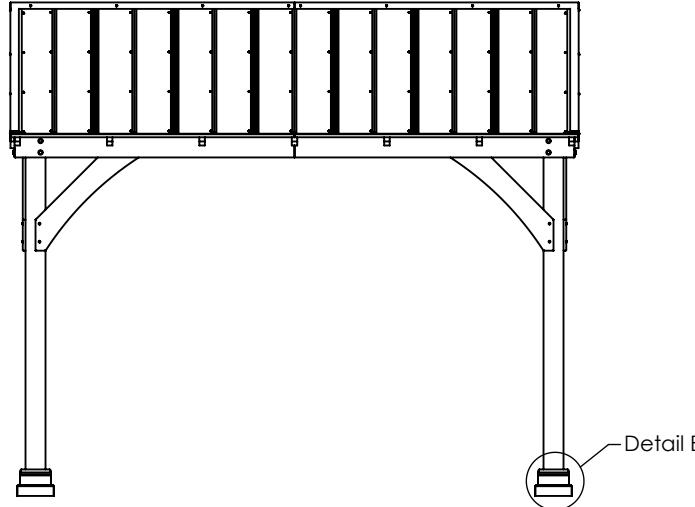

Side Elevation

 YardCraft® rediscover life outdoors 191 JALYN DRIVE NEW HOLLAND, PA 17557 PH: 1-866-210-9273 WWW.YARDCRAFT.COM		
THIS DRAWING IS THE PROPERTY OF YARD CRAFT, ANY REPRODUCTION, ALTERATION, OR USE OF THIS DRAWING, WITHOUT THE WRITTEN CONSENT OF YARD CRAFT, IS PROHIBITED. DRAWINGS SHALL NOT BE SCALED TO OBTAIN DIMENSIONS. THE CONTRACTORS/DEALERS, AND BUILDERS INVOLVED ON THIS PROJECT SHALL VERIFY ALL DIMENSIONS AND CONDITIONS BEFORE STARTING WORK. ANY DISCEPANCY SHALL BE REPORTED IN WRITING BEFORE STARTING WORK.		
CONTRACTOR: YardCraft		
DRAWING TITLE: Elevation Plans		
PROJECT: 12x12 A-Frame Pavilion		
COMMENTS:		
REVISIONS: DATE: BY:		
DRAWING NUMBER: 18-552		
DATE: 8/17/2018 PAGE: 1 of 10		
BY: JR. SCALE: 1:48		

DESIGN REQUIREMENTS

1. Governing Code:
Including, not limited to: IBC 2015 (ASCE 7-10)
Risk Category: 1
2. Live Load: 10 psf
3. Ground Snow Load: 30 psf with 2x6 Headers.
45 psf if upgraded to 2x8 Headers.
4. Wind Load:
Basic Wind Speed (V): 140 mph
Open Building, Unrestricted Flow
5. Uplift at each Column Base: 108 lb.



191 JALYN DRIVE NEW HOLLAND, PA 17557
PH: 1-866-210-9273

WWW.YARDCRAFT.COM

THIS DRAWING IS THE PROPERTY OF YARD CRAFT,
ANY REPRODUCTION, ALTERATION, OR USE OF
THIS DRAWING, WITHOUT THE WRITTEN CONSENT
OF YARD CRAFT, IS PROHIBITED. DRAWINGS
SHALL NOT BE SCALED TO OBTAIN DIMENSIONS.
THE CONTRACTORS/DEALERS, AND BUILDERS
INVOLVED ON THIS PROJECT SHALL VERIFY ALL
DIMENSIONS AND CONDITIONS BEFORE
STARTING WORK. ANY DISCEPANCY SHALL BE
REPORTED IN WRITING BEFORE STARTING WORK.

CONTRACTOR:
YardCraft

DRAWING TITLE:
Post Layout Plan

PROJECT:
12x12 A-Frame Pavilion


COMMENTS:

REVISIONS: DATE: BY:

DRAWING NUMBER: 18-552

DATE: 8/17/2018 PAGE: 2 of 10

BY: JR. SCALE: 1:36

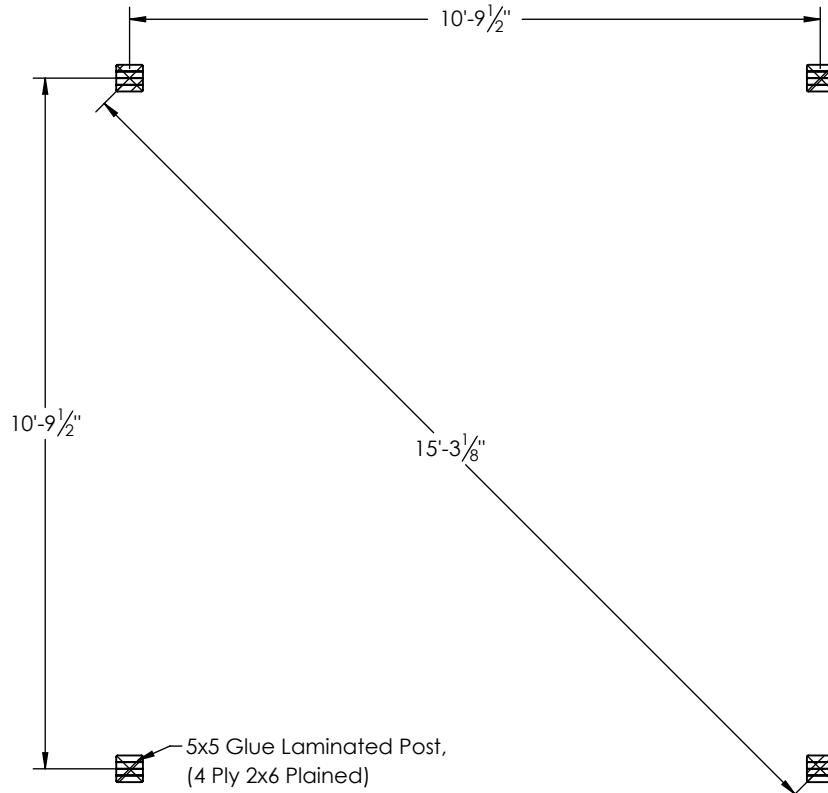

Post Layout Plan



191 JALYN DRIVE NEW HOLLAND, PA 17557
PH: 1-866-210-9273

WWW.YARDCRAFT.COM

THIS DRAWING IS THE PROPERTY OF YARD CRAFT, ANY REPRODUCTION, ALTERATION, OR USE OF THIS DRAWING, WITHOUT THE WRITTEN CONSENT OF YARD CRAFT, IS PROHIBITED. DRAWINGS SHALL NOT BE SCALED TO OBTAIN DIMENSIONS. THE CONTRACTORS/DEALERS, AND BUILDERS INVOLVED ON THIS PROJECT SHALL VERIFY ALL DIMENSIONS AND CONDITIONS BEFORE STARTING WORK. ANY DISCEPANCY SHALL BE REPORTED IN WRITING BEFORE STARTING WORK.

CONTRACTOR:
YardCraft

DRAWING TITLE:
Roof Framing Plan

PROJECT:
12x12 A-Frame Pavilion


COMMENTS:

REVISIONS: DATE: BY:

DRAWING NUMBER: 18-552

DATE: 8/17/2018 PAGE: 3 of 10

BY: JR. SCALE: 1:36

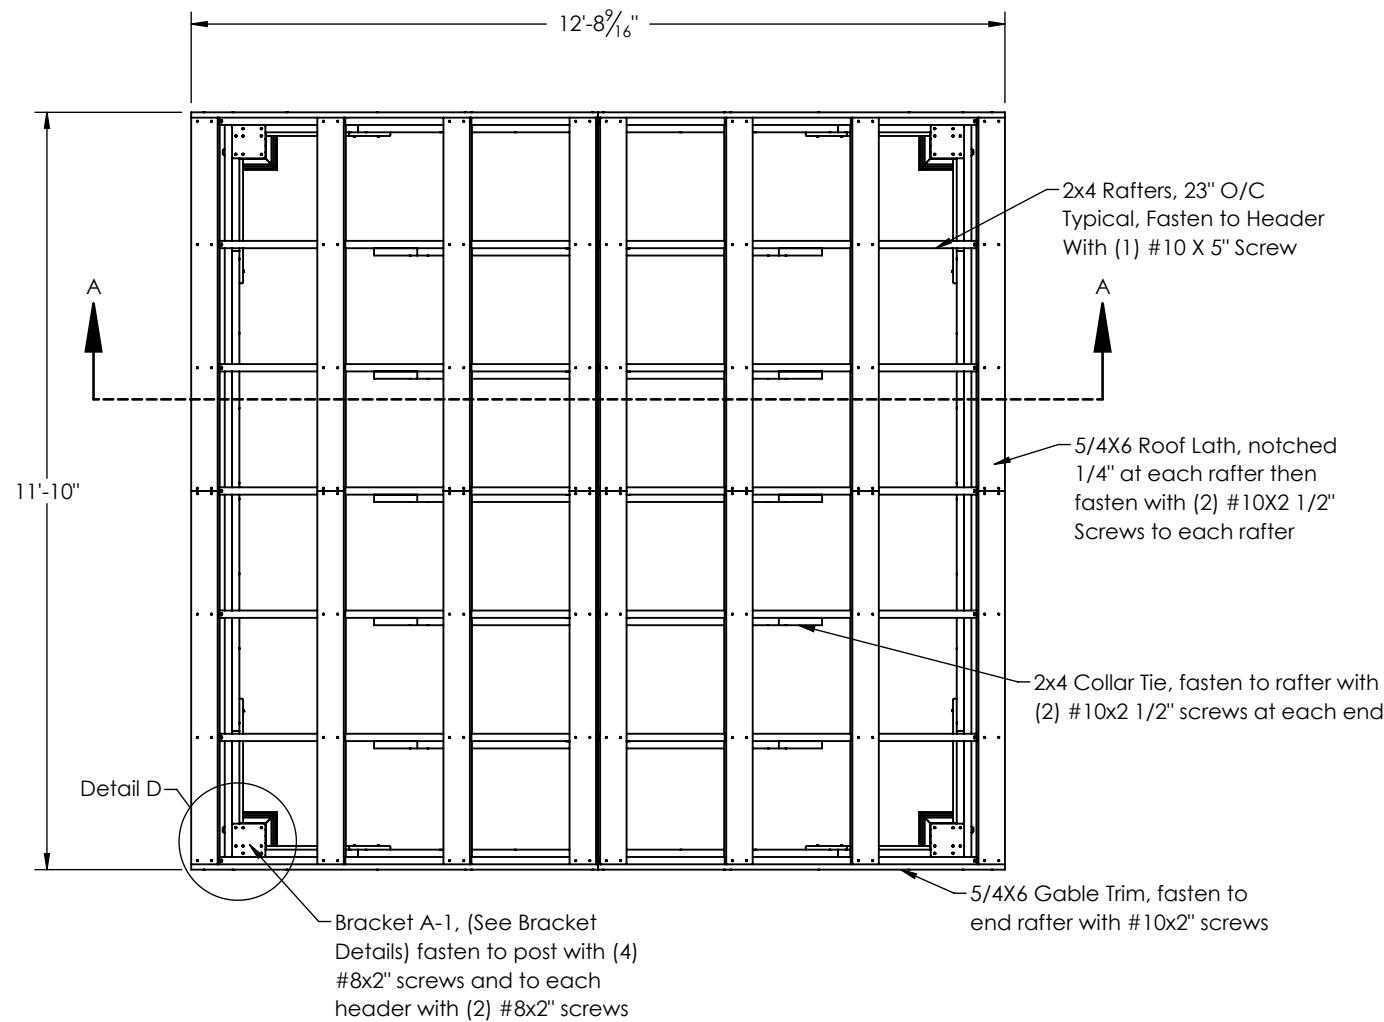

Roof Framing Plan



191 JALYN DRIVE NEW HOLLAND, PA 17557
PH: 1-866-210-9273

WWW.YARDCRAFT.COM

THIS DRAWING IS THE PROPERTY OF YARD CRAFT,
ANY REPRODUCTION, ALTERNATION, OR USE OF
THIS DRAWING, WITHOUT THE WRITTEN CONSENT
OF YARD CRAFT, IS PROHIBITED. DRAWINGS
SHALL NOT BE SCALED TO OBTAIN DIMENSIONS.
THE CONTRACTORS/DEALERS, AND BUILDERS
INVOLVED ON THIS PROJECT SHALL VERIFY ALL
DIMENSIONS AND CONDITIONS BEFORE
STARTING WORK. ANY DISCREPANCY SHALL BE
REPORTED IN WRITING BEFORE STARTING WORK.

CONTRACTOR:
YardCraft

DRAWING TITLE:
Cross Section

PROJECT:


COMMENTS:

REVISIONS: DATE: BY:

DATE: 8/17/2018

PAGE: 4 of 10

BY: JR. SCALE: 1:24

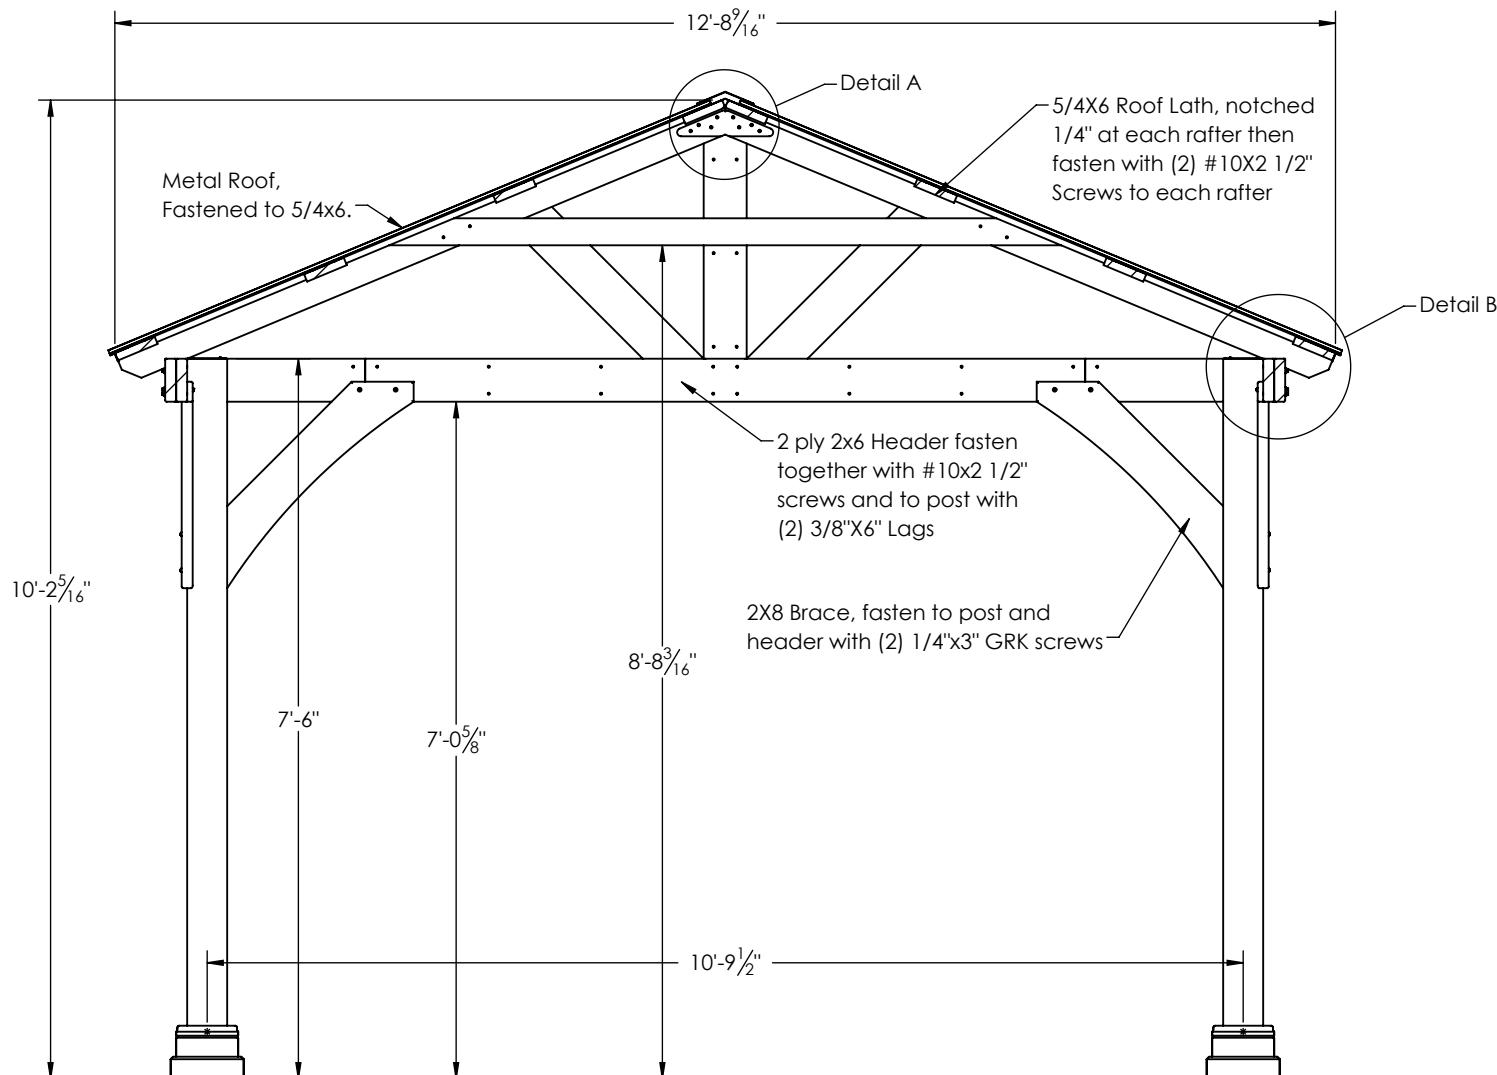

CROSS SECTION A-A